

Project Duration: 45 calendar days



PROJECT TITLE:

Republic of the Philippines
Office of the President

PROP

JOHN HAY MANAGEMENT CORPORATION

PROPOSED RESTROOM AT SCOUT HILL

CAMP JOHN HAY, BAGUIO CITY

PHILIPPINES

LOCATION

AR. LEONARDO JR. B. BIASURA

PREPARED BY:

AR. LUZVIMINDA NIGOS PANGANIBAN


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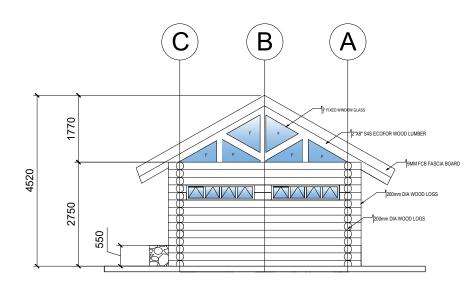
ENGR. BOBBY V. AKIA

APPROVED BY:


REVISION NO. 12

SHEET NO.




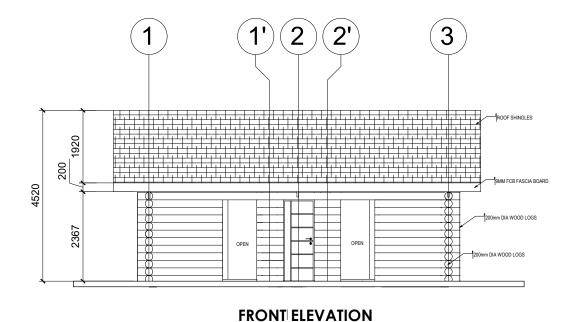

RIGHT SIDE ELEVATION

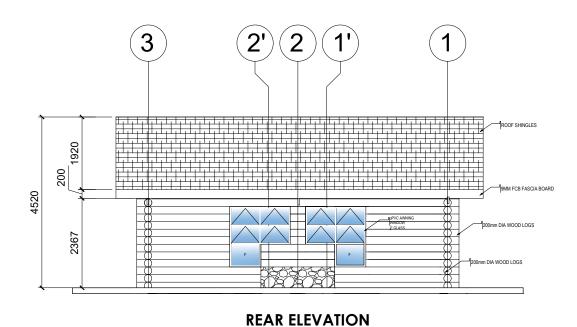

LOCATION

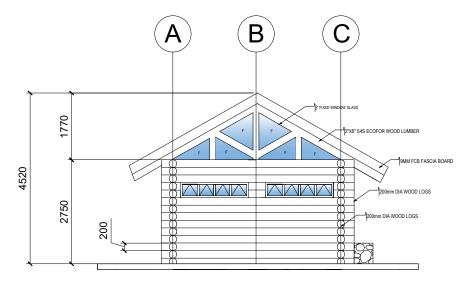

LEFT SIDE ELEVATION



PREPARED BY:



PROPOSED RESTROOM AT SCOUT HILL

CAMP JOHN HAY, BAGUIO CITY PHILIPPINES

AR. LEONARDO JR. B. BIASURA

AR. LUZVIMINDA NIGOS PANGANIBAN PMD MANAGER


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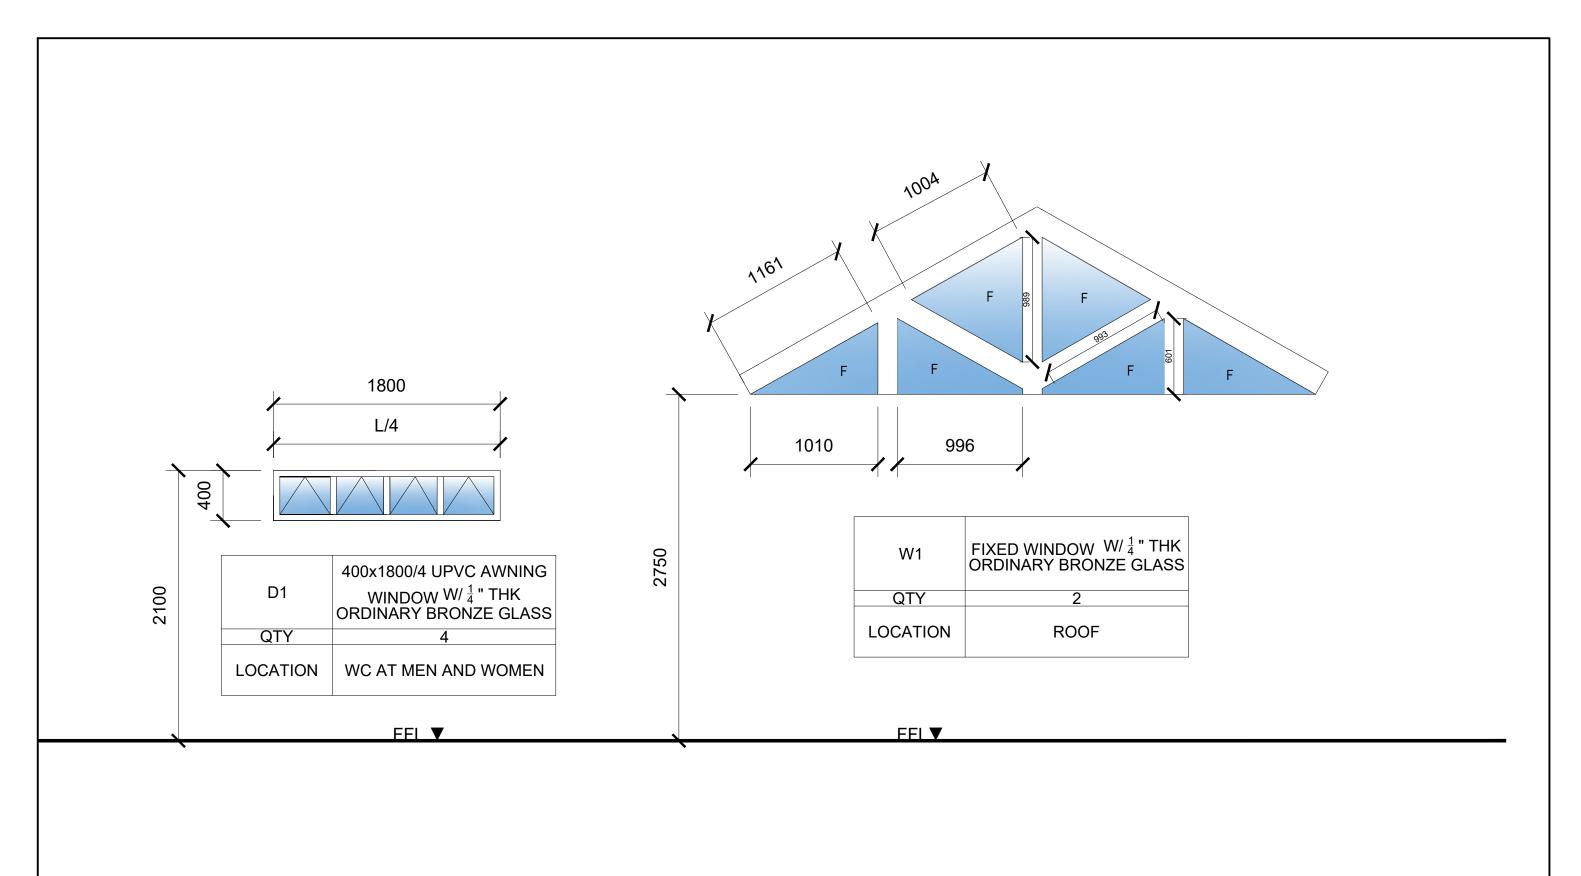
ENGR. BOBBY V. AKIA
EAMD MANAGER

APPROVED BY:


REVISION NO. 2

SHEET NO.



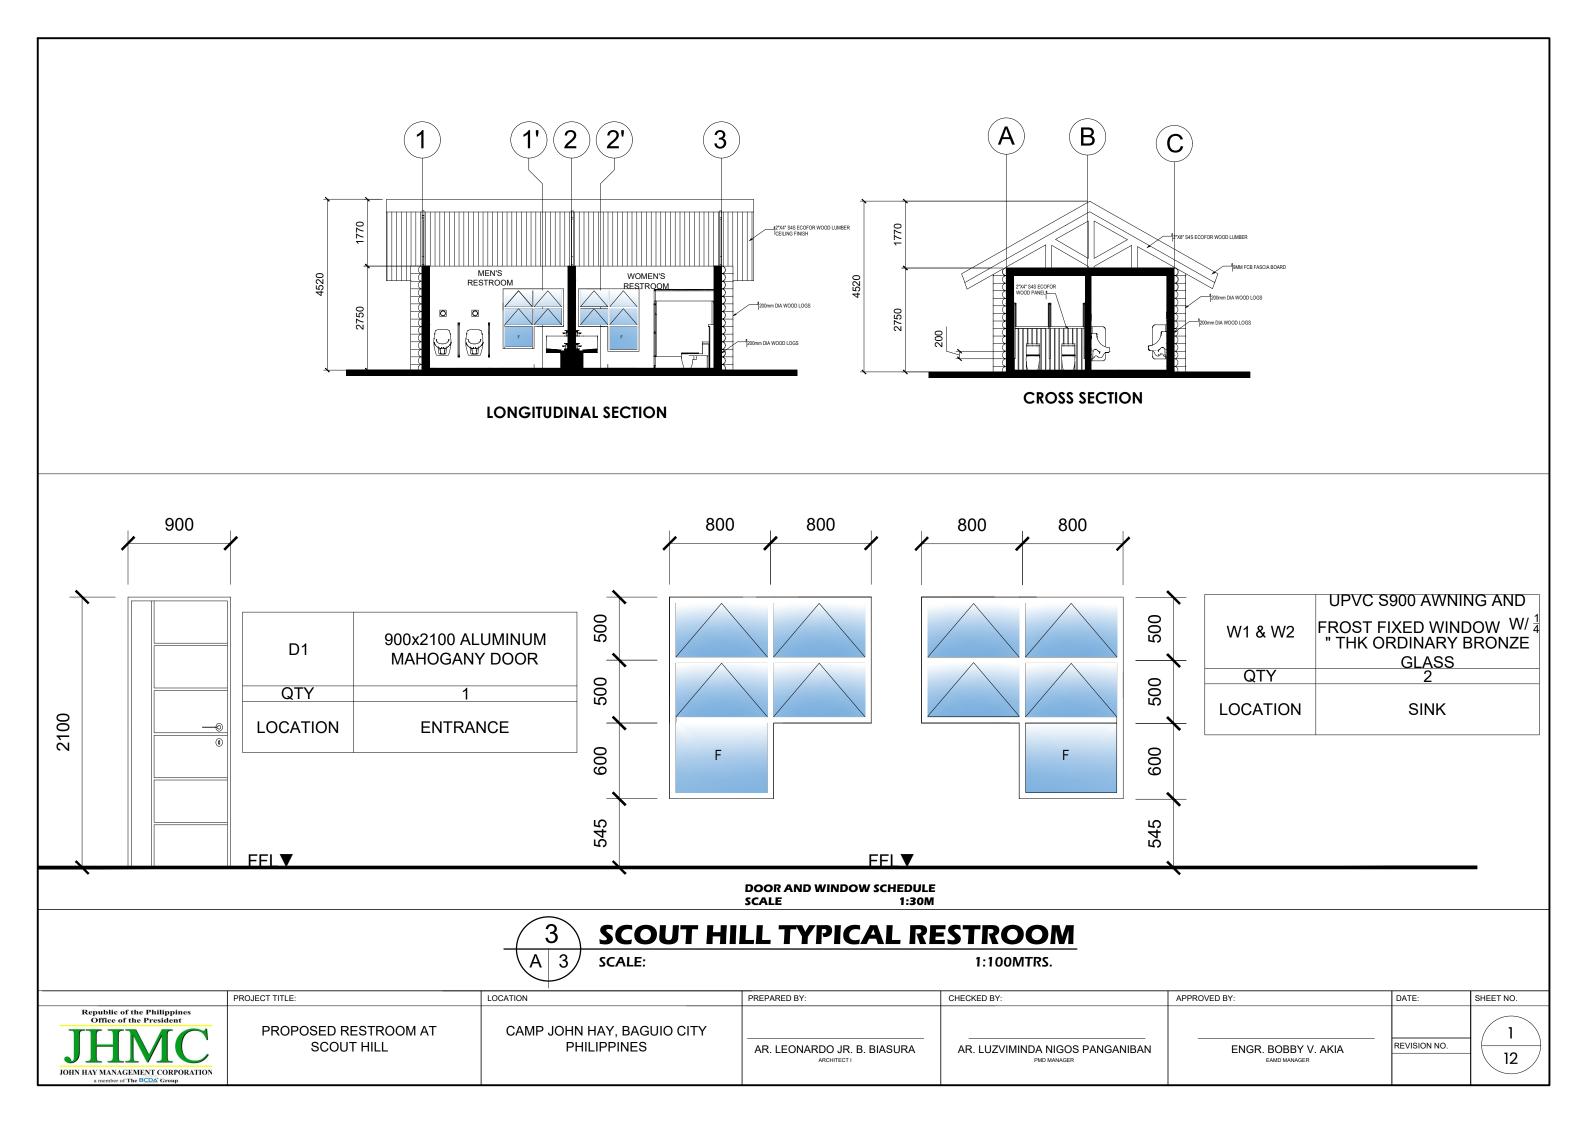

DOOR AND WINDOW SCHEDULE SCALE 1:30M

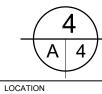

SCOUT HILL TYPICAL RESTROOM

SCALE: 1:100MTRS.

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PROPULATION
JOHN HAY MANAGEMENT CORPORATION
A DESCRIPTION OF THE PROPULATION OF THE PROPULATION

PROPOSED RESTROOM AT SCOUT HILL

CAMP JOHN HAY, BAGUIO CITY PHILIPPINES

AR. LEONARDO JR. B. BIASURA

AR. LUZVIMINDA NIGOS PANGANIBAN

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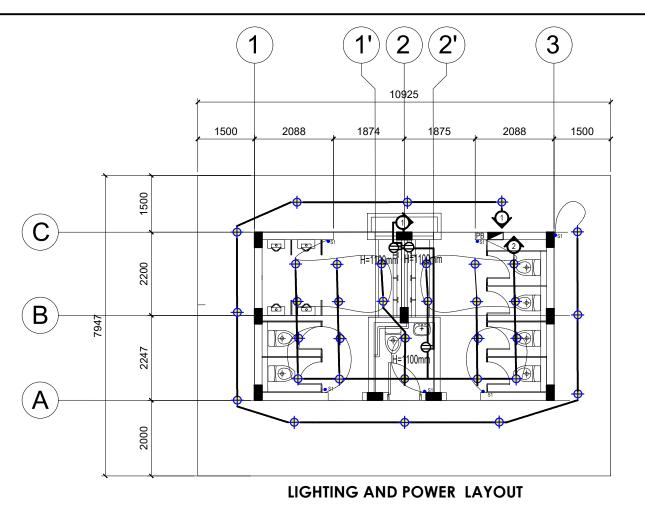
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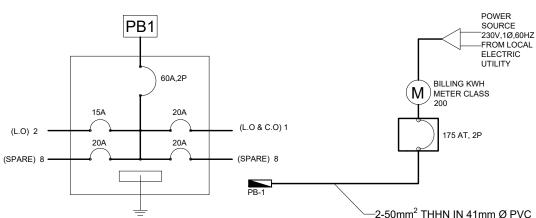
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REVISION NO. 12

SHEET NO.






BREAKER DIAGRAM PB-1

PROJECT TITLE:


FEEDER-RISER DIAGRAM

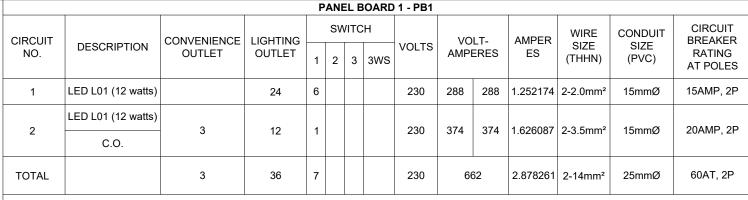

LOAD COMPUTATION PB-1 I TOT @ 80% D.F = 662/230V X 0.80 + 25% X 17A = 2.30+4.25 = 6.55 AMPERES

USE: 2-14mm² THHN, FOR SERVICE FEEDER CONDUCTOR USE: 60 AT, 2 POLES, 240 VOLTS, 10 KAIC FOR SERVICE EQUIPMENT

LOAD TABULATION AND COMPUTATION PB-1

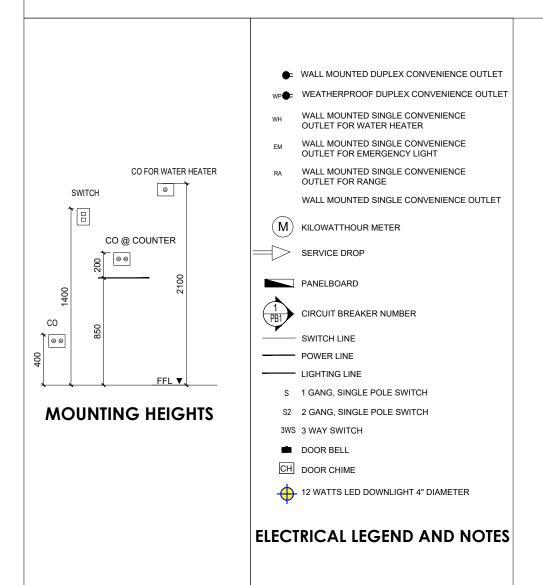

DONE IN ACCORDANCE WITH THE PHILIPPINE ELECTRICAL CODE, WITH THE RULES AND REGULATIONS OF NATIONAL AND LOCAL AUTHORITIES CONCERNED IN THE ENFORCEMENT OF ELECTRICAL LAWS AND WITH THE RULES AND REGULATIONS OF THE UTILITY COMPANIES CONCERNED.

1.0 ALL ELECTRICAL WORKS HEREIN SHALL BE

- 2.0 SERVICE VOLTAGE TO THE BUILDING SHALL BE 220V, 60HTZ, SINGLE PHASE THREE-WIRE SYSTEM.
- 3.0 THE CONTRACTOR SHALL VERIFY AND ORIENT THE ACTUAL LOCATION OF THE CONCRETE TERMINAL POLE FOR CONNECTION TO THE POWER SUPPLY AND TELEPHONE SERVICE.
- 4.0 ALL INSTALLATIONS SHALL BE CONCEALED FROM VIEW, WIRING SHALL BE ENCASED IN POLYVINYL CHLORIDE(PVC) PIPES SCHED.40 EXCEPT POWER AND TELEPHONE SERVICE ENTRANCE WHICH SHALL BE IN RIGID STEEL CONDUIT(RSC) UNLESS OTHERWISE NOTED.
- 5.0 MINIMUM WIRE AND CONDUIT SIZE SHALL BE 3.5mm TW AND 12mm TRADE SIZE. RESPECTIVELY UNLESS OTHERWISE SPECIFIED.
- 6.0 PULL BOXES OF APPROPRIATE SIZES SHALL BE PROVIDED, EVEN IF NOT INDICATED DRAWINGS TO ACCOMMODATE THE NUMBER OF SPLICES OR WIRES.
- 7.0 ALL FLUORESCENT LAMPS SHALL BE PROVIDED WITH POLYESTER FILLED, PRE HEAT THERMALLY PROTECTED HIGH POWER
- 8.0 ALL MATERIALS TO BE USED SHALL BE NEW AND APPROVED TYPE APPROPRIATE FOR BOTH LOCATION AND INTENDED USE.
- 9.0 LIGHT CONTROL SWITCHES SHALL BE RATED 10A 250V AND SHALL NOT CARRY A LOAD GRATER THAN 50 AMPS. LIGHT SWITCHES SHALL BE INSTALLED FOR OPERATION WITH VERTICAL MOTION.
- 10.0 FOR EACH SPARE CIRCUIT IN PANEL BOARD, PROVIDE EMPTY 19mm Ø RISER TERMINATING IN A 58mm x 100mm OCTAGONAL BOX ABOVE CEILING
- 11.0 ELECTRICAL INSTALLATION SHALL BE UNDER THE DIRECT SUPERVISION OF A DULY LICENSED ELECTRICAL ENGINEER.



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PROPOSED RESTROOM AT SCOUT HILL

CAMP JOHN HAY, BAGUIO CITY **PHILIPPINES**

LOCATION

AR. LEONARDO JR. B. BIASURA

AR. LUZVIMINDA NIGOS PANGANIBAN


1:100 MTRS.


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ENGR. BOBBY V. AKIA

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WATERLINE LAYOUT

1 SCOUT HILL TYPICAL RESTROOM
P 1 SCALE: 1:100 MTRS.

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JOHN HAY MANAGEMENT CORPORATION
A MANAGE

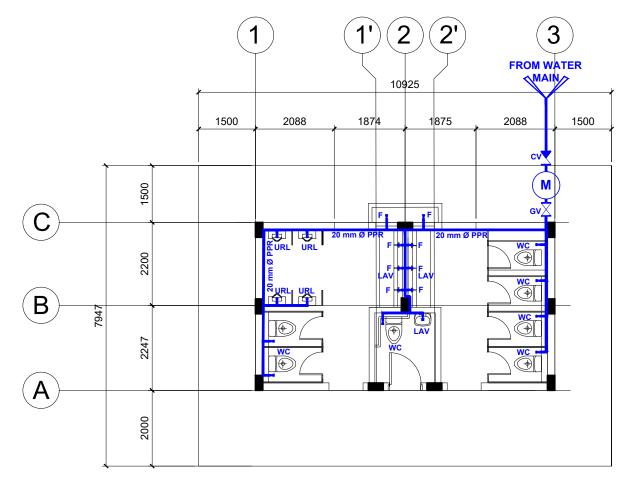PROPOSED RESTROOM AT SCOUT HILL

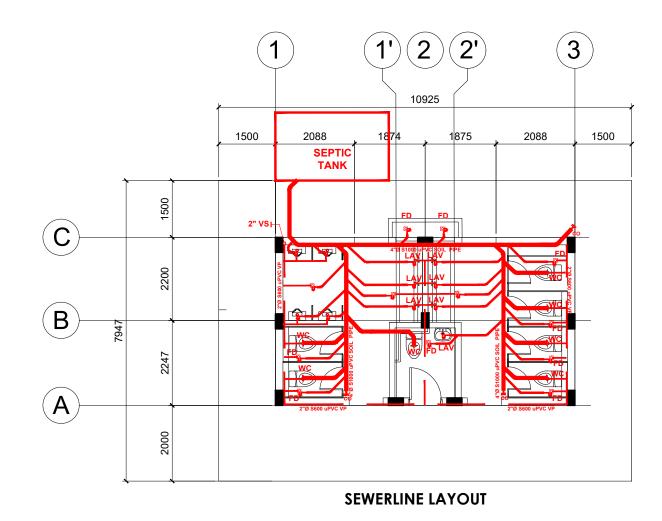CAMP JOHN HAY, BAGUIO CITY PHILIPPINES

LOCATION

AR. LEONARDO JR. B. BIASURA

AR. LUZVIMINDA NIGOS PANGANIBAN PMD MANAGER

CHECKED BY:

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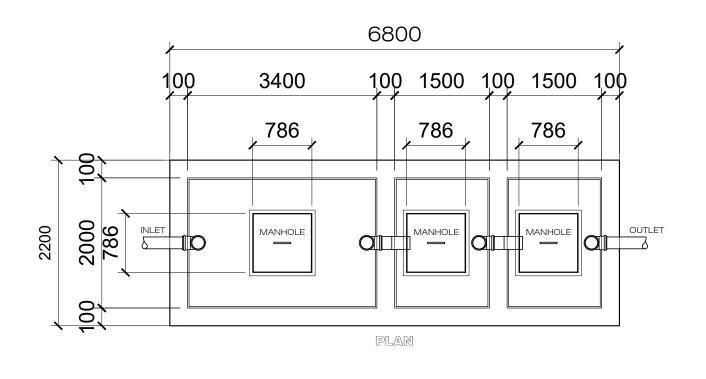
EAMD MANAGER


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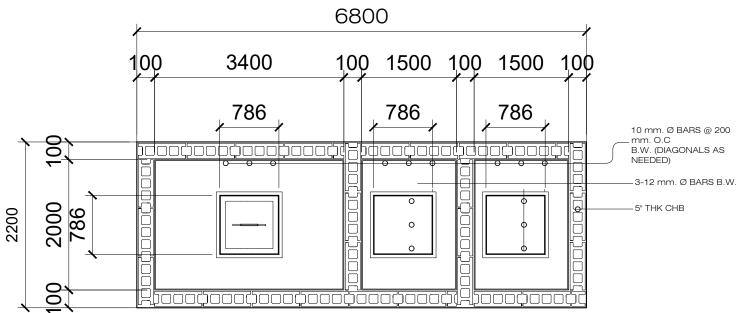
APPROVED BY:

REVISION NO. 6

SHEET NO.





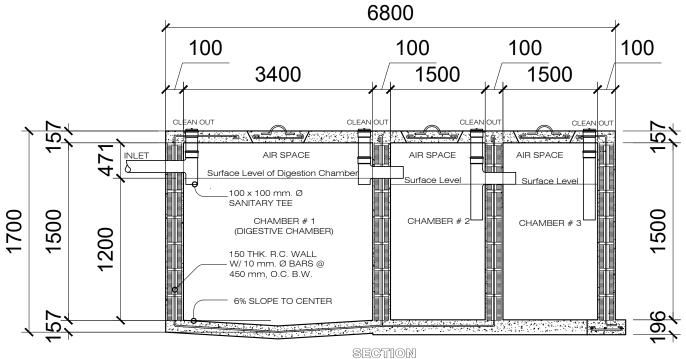

FRAMING PLAN

LOCATION

COMPUTATION:

TYPE OF OCCUPANCY
OUTDOOR PUBLIC RESTROOM
NO. OF OCCUPANTS
300 PERSONS

QUANTITY OF SEWAGE FLOW PER PERSON/DAY (*P.D. 856 CHAPTER 17-TABLE 1*) 75 Liters / DAY / PERSON

Q= 300 X 75 Liters / DAY / PERSON Q= 22,500 Liters/DAY

V (VOLUME) = 22,500 L $\times \frac{1 \text{ M}^3}{1000 \text{ L}}$ = 22.5 M³

*INSIDE DIMENSIONS AS PER PLAN

APPROVED BY:

 $\begin{array}{ll} \mbox{L (LENGTH)} & = 3.40 \mbox{ M.} + 1.70 \mbox{ M.} + 1.70 \mbox{ M.} \\ \mbox{W (WIDTH)} & = 2.20 \mbox{ M} \\ \end{array}$

D (DEPTH) = 1.50 M

VOLUME= 22.50 M³



PREPARED BY:



PROPOSED RESTROOM AT SCOUT HILL

CAMP JOHN HAY, BAGUIO CITY PHILIPPINES

AR. LEONARDO JR. B. BIASURA

AR. LUZVIMINDA NIGOS PANGANIBAN

CHECKED BY:

ENGR. BOBBY V. AKIA

REVISION NO. 7

DATE:

SHEET NO.

- 1.0. ALL WORKS HEREIN SHALL BE DONE IN ACCORDANCE WITH THE LATEST EDITION OF THE NATIONAL PLUMBING CODE OF THE PHILIPPINES AND LOCAL CODE REQUIREMENTS.
- 2.0. THE PLUMBING LAYOUT IS ONLY DIAGRAMATIC. PIPES, CLEANOUTS AND CHECK VALVES SHALL BE CONCEALED AS MUCH AS POSSIBLE.
- 3.0. PIPES SHALL NOT BE EMBEDDED IN STRUCTURAL MEMBERS UNLESS OTHERWISE SPECIFIED AND/OR ALLOWED.
- 4.0. RUN ALL HORIZONTAL PIPING IN PERFECT ALIGNMENT AND AT UNIFORM GRADE OF NOT LESS THAN SLOPE OF 1: 50 FOR SEWER LINES AND 1: 100 FOR DRAINAGE LINES.
- 5.0. ALL FLOOR DRAINS SHALL BE VENTED INDIVIDUALLY.
- 6.0. ALL CLEANOUTS SHALL BE FLUSHED MOUNTED TO WALL AND PROVIDED WITH COVER CAPS. DO NOT INSTALL FLOOR CLEANOUTS EXCEPT AT LINES ON GRADE AND SERVICE AREAS NOT SERVICE T TRAFFIC.
- 7.0. ALL SANITARY SEWER PIPES AND FITTINGS SHALL BE POLYVINYL CHLORIDE (PVC) PIPES. WATER DISTRIBUTION SHALL BE POLYPROPELYNE (PPR) PIPES.
- 8.0. PROVIDE VENT PIPES AND VENT STACK THRU ROOF AS REQUIRED.
- 9.0. PROVIDE GATE VALVES ON ALL WATER SUPPLY LINES TO FIXTURES.
- 10. ALL INDIVIDUAL BRANCHES TO FIXTURES OR GROUPS OF FIXTURES AND/OR EQUIPMENTS SHALL BE PROVIDED WITH AIR CHAMBERS OR CAPPED UP WITH VERTICAL PIPE EXTENSION OF DIMENSIONS AS SHOWN.


h = 450mm for 19mm Ø PIPE h = 300mm for 12mm Ø PIPE

PROJECT TITLE:

11. ALL PLUMBING WORKS SHALL BE DONE UNDER THE DIRECT SUPERVISION OF A DULY LICENSED SANITARY ENGINEER OR A MASTER PLUMBER.



LEGEND			
GV GV	GATE VALVE		
cv	CHECK VALVE		
HMH	METER		
SHO	SHOWER		
LAV	LAVATORY		
WC	WATER CLOSET		
FD	FLOOR DRAIN		
F	FAUCET		
KS	KITCHEN SINK		
СВ	CATCH BASIN		
МН	MANHOLE		
C.O	CLEAN OUT		
VTR	VENT THRU ROOF		
BP	BOOSTER PUMP		
PS	PRESSURE TANK		
WT	WATER TANK		
FV	FLOAT VALVE		
PS	PRESSURE SWITCH		

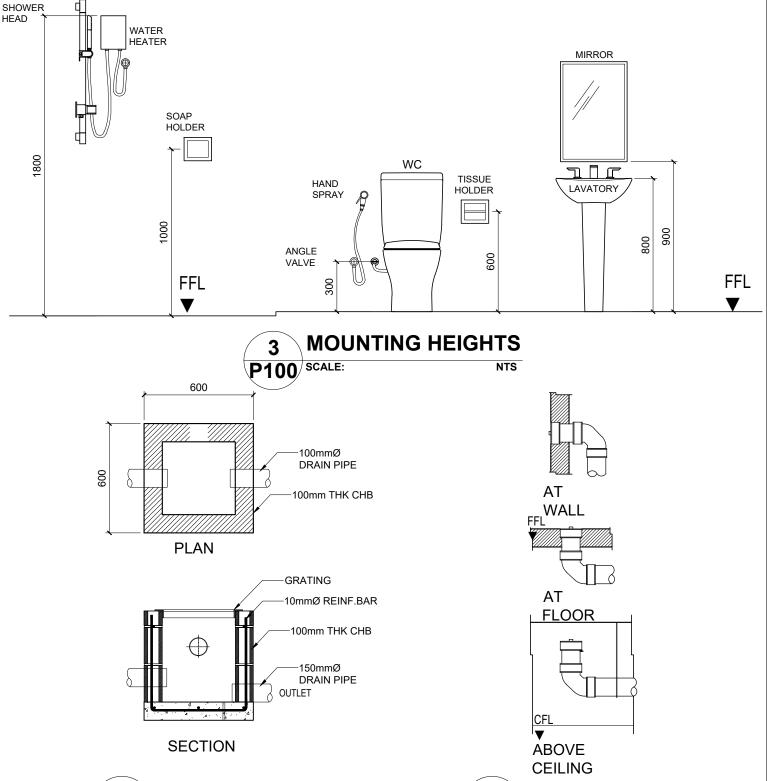





CHECKED BY:





LOCATION

SCOUT HILL TYPICAL RESTROOM

SCALE: 1:100 MTRS.

PREPARED BY:

Republic of the Philippines
Office of the President

JHMC

JOHN HAY MANAGEMENT CORPORATION

PROPOSED RESTROOM AT SCOUT HILL

CAMP JOHN HAY, BAGUIO CITY PHILIPPINES

AR. LEONARDO JR. B. BIASURA


AR. LUZVIMINDA NIGOS PANGANIBAN PMD MANAGER ENGR. BOBBY V. AKIA


EAMD MANAGER

REV

APPROVED BY:

REVISION NO.

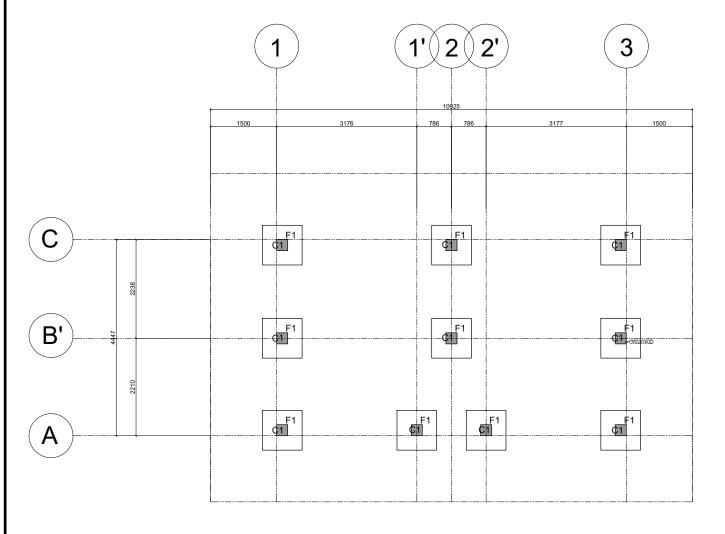

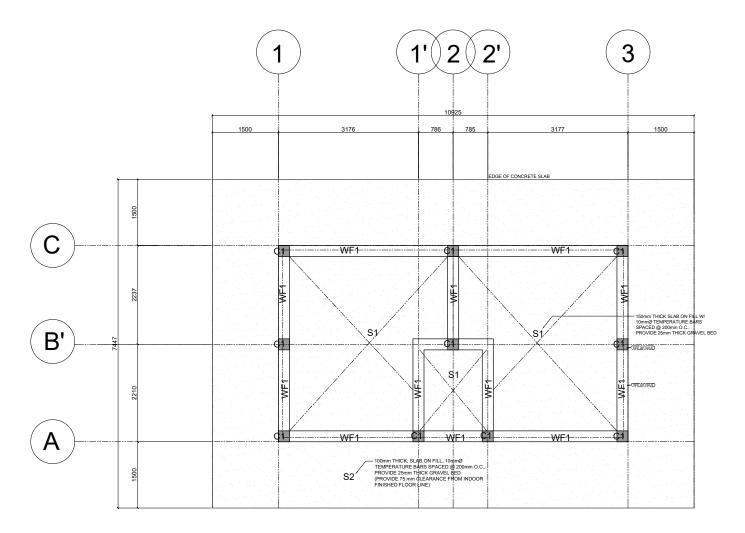





DATE:



ROJECT NAME AND LOCATION: CONSTRUCTION OF TWO (2) UNITS RESTROOM AT THE SCOUT HILL AREA

COLUMN & FOUNDATION PLAN SLAB AND WALL FOOTING PLAN

SHEET CONTENTS:


PREPARED BY: ENGR. LARA MELISSA C. ANTONIO


CHECKED/REVIEWED BY: AR. LUZVIMINDA N. PANGANIBAN APPROVED BY: ENGR. BOBBY V. AKIA


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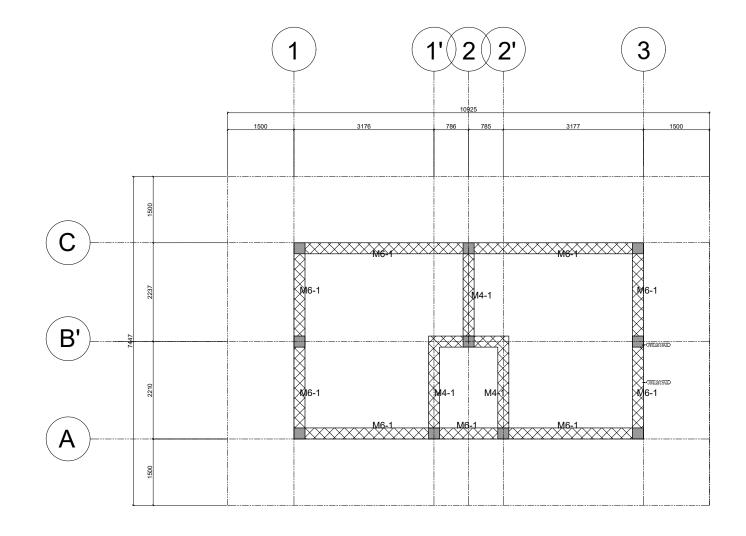
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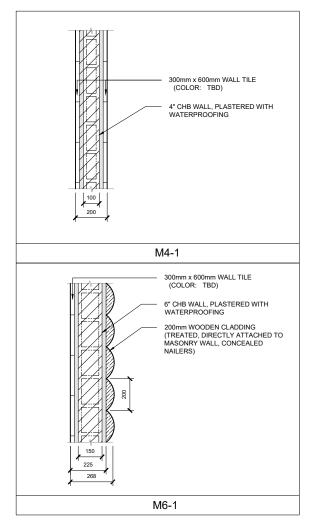







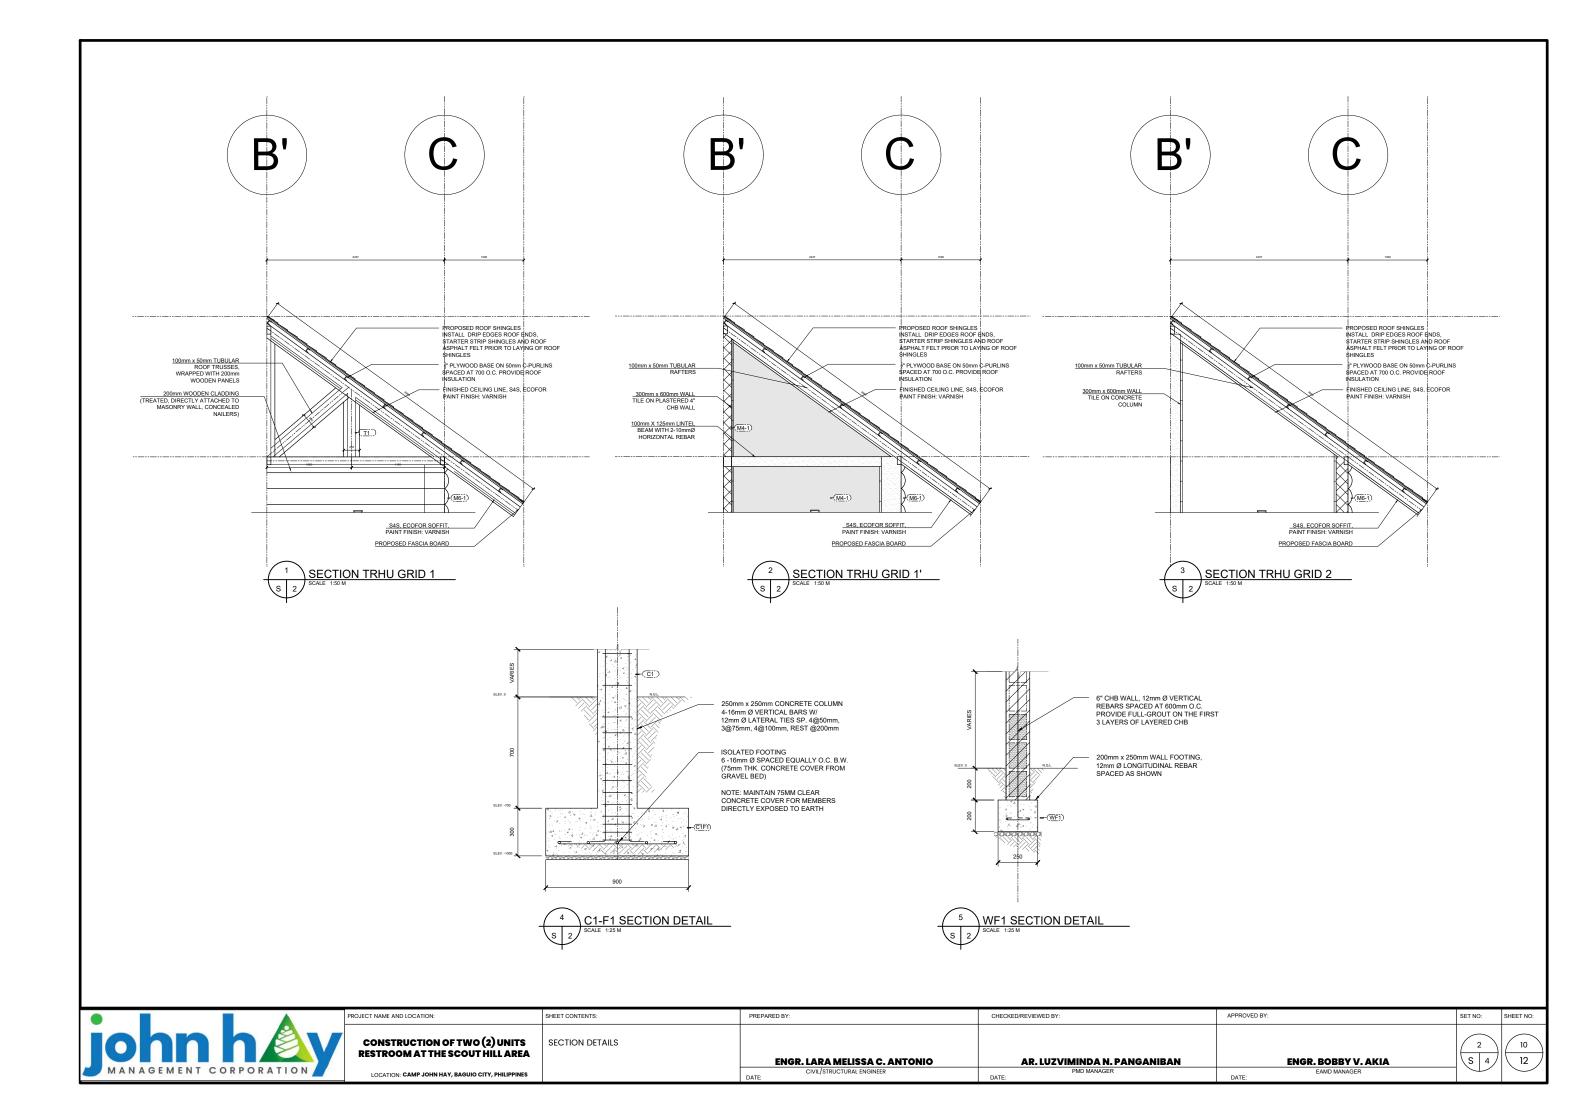

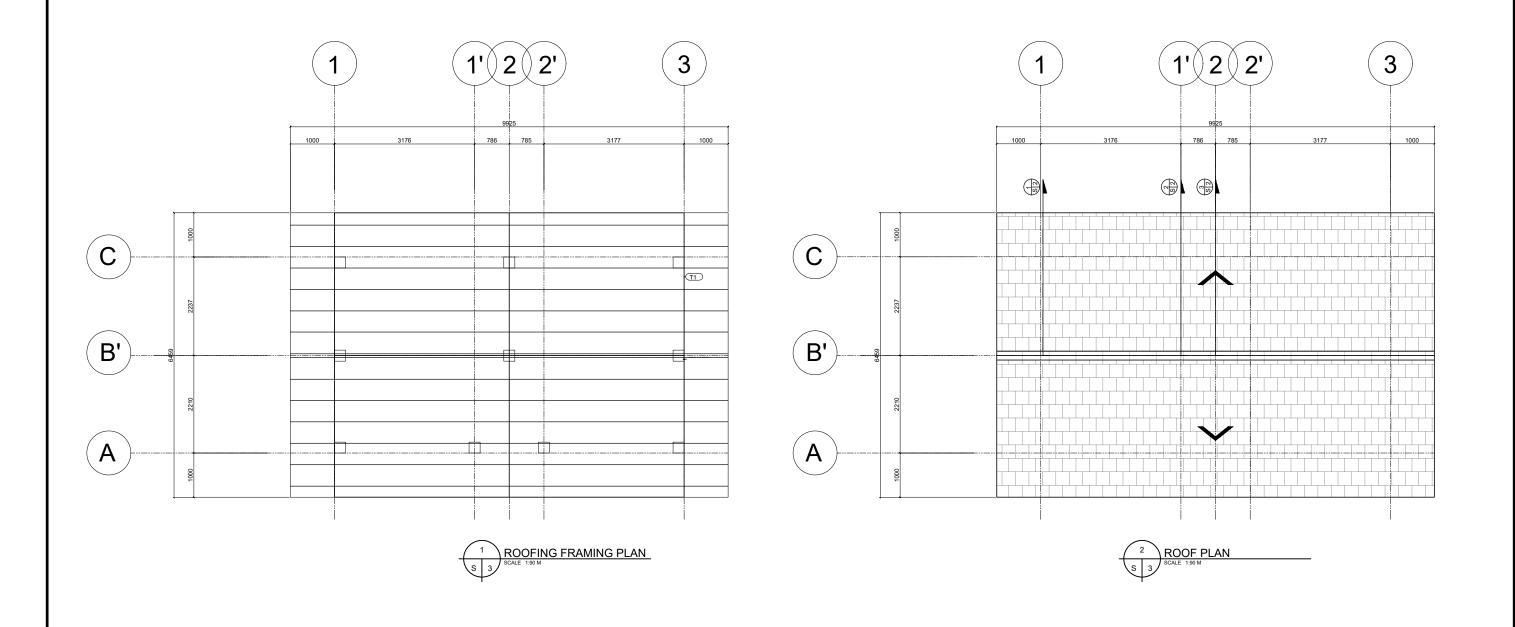

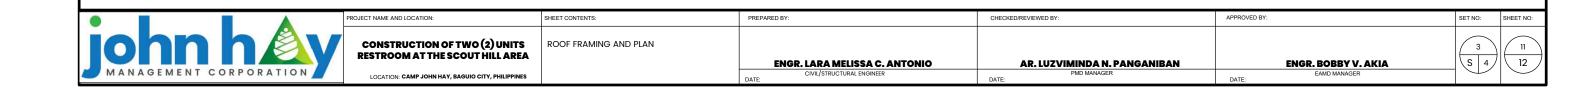

WALL LEGEND

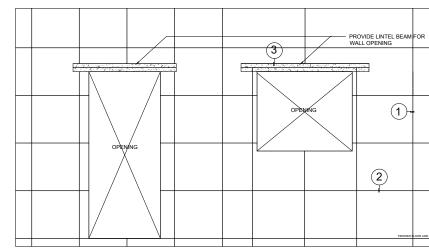

- 1. 12mm Ø VERTICAL REBAR SPACED AT 600mm O.C.
 2. 12mm Ø HORIZONTAL REBAR SPACED AT 600mm O.C.
 LINTEL BEAMS PROVIDED FOR EVERY OPENING ON THE PROPOSED MASONRY WALL TO SUPPORT ADDITIONAL LAYER OF CHB
 4. LAPPING SHOULD BE AT LEAST 200MM FOR 16mm Ø

	PROJECT NAME AND LOCATION:	SHEET CONTENTS:	PREPARED BY:	CHECKED/REVIEWED BY:	APPROVED BY:	SET NO: SHEET NO:
john hay	CONSTRUCTION OF TWO (2) UNITS RESTROOM AT THE SCOUT HILL AREA	WALL DETAILS	ENGR. LARA MELISSA C. ANTONIO	AR. LUZVIMINDA N. PANGANIBAN	ENGR. BOBBY V. AKIA	$\left \begin{array}{c c} 4 \\ \hline S & 4 \end{array}\right \left(\begin{array}{c c} 12 \\ \hline 12 \end{array}\right)$
MANAGEMENT CORPORATION	LOCATION: CAMP JOHN HAY, BAGUIO CITY, PHILIPPINES		CIVIL/STRUCTURAL ENGINEER DATE:	PMD MANAGER DATE:	EAMD MANAGER DATE:	